


SEE DWG. A-3 FOR LIGHT FIXTURE LEGEND

Sheet 5 of 4-1

THE PORT AUTHORITY  
OF NY & NJ

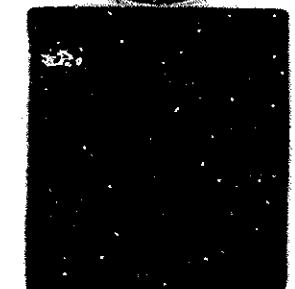

James J. Conaway  
Engineering Program Manager

3/15/01 Drawings of Record  
No. Date Revision Approved

Engineering Department  
Design Division

The World Trade  
Center  
Electrical/HVAC  
Upgrade Program


LOW VOLTAGE DISTRIBUTION  
ONE WTC  
ARCHITECTURAL  
32ND FLOOR  
NORTH & SOUTH SIDE  
REFLECTED CEILING  
PLANS & SECTIONS

This drawing subject to conditions in contract.  
All inventions, ideas, designs and methods  
herein are reserved to Port Authority and  
may not be used without its written consent.

S.C.A.M.S. S.C.S.P.P.  
Designed by Drawn by Checked by


Date 10-4-93 Scale AS NOTED

Contract Number Drawing Number  
WTC-804.041 A-2

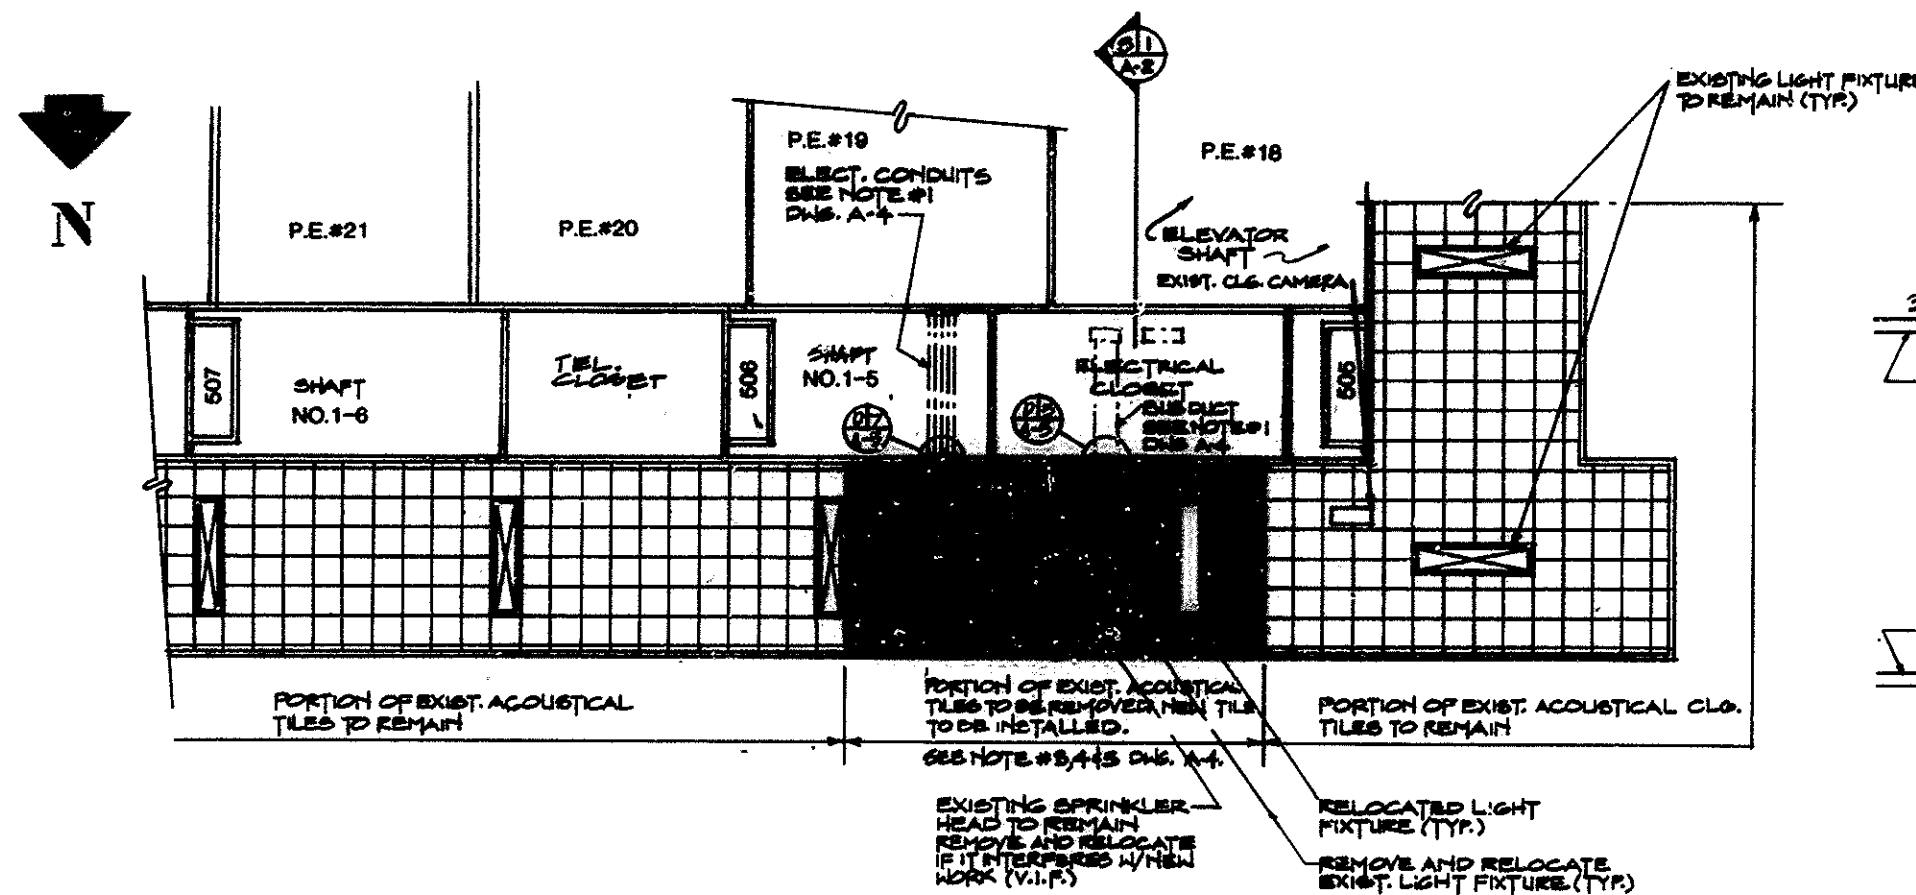


32 NORTH-REFLECTED CEILING PLAN

SCALE IN FEET

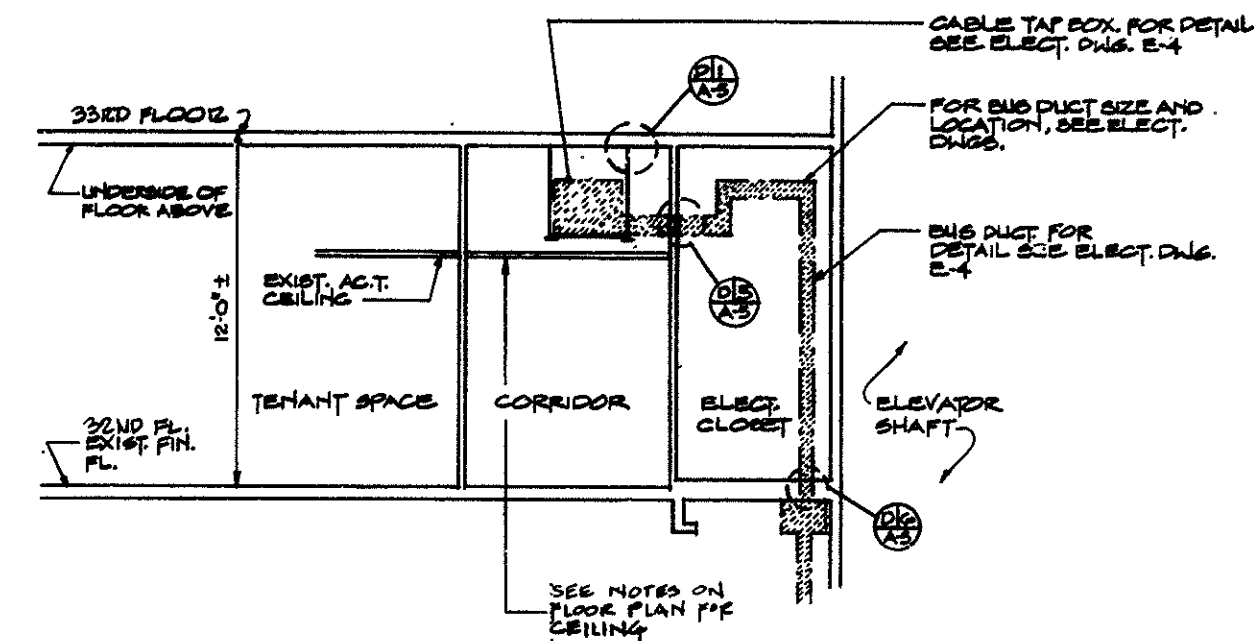


S1 SECTION  
A-2

SCALE IN FEET

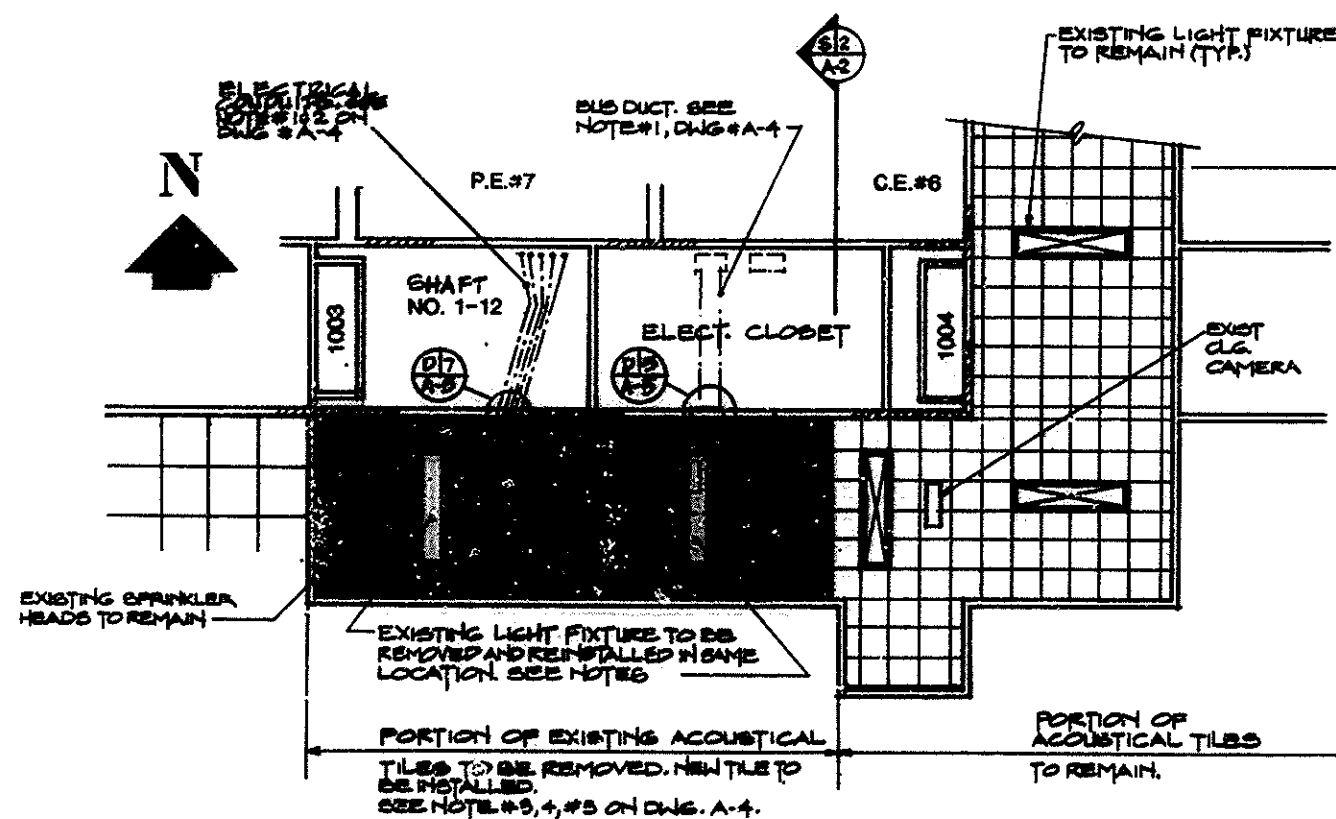


32 SOUTH-REFLECTED CEILING PLAN

SCALE IN FEET

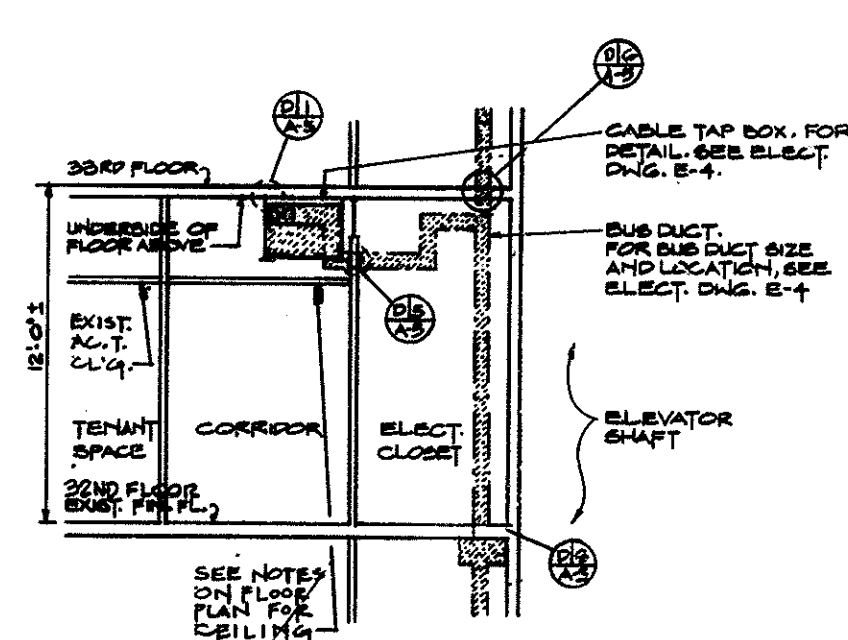

S2 SECTION  
A-2

SCALE IN FEET

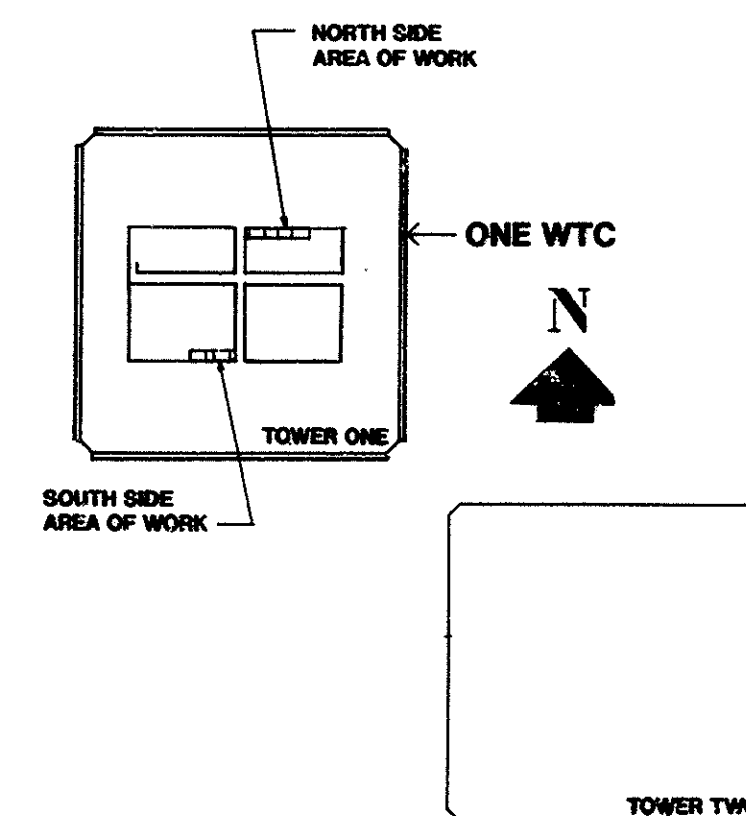

KEY PLAN  
NO SCALE